

100'

GENERAL NOTES

- ALL STRUCTURAL WORK SHALL BE COORDINATED WITH ARCHITECTURAL AND MECHANICAL DRAWINGS AND SHALL CONFORM TO THE PROJECT SPECIFICATIONS, INCLUDING THE 2018 IRC.
- 2. CONTRACTOR SHALL PROVIDE TEMPORARY SHORING, BRACING, SHEETING AND MAKE SAFE ALL FLOORS, ROOFS, WALLS AND ADJACENT PROPERTY AS PROJECT CONDITIONS REQUIRE. SHORING AND SHEETING SHALL BE DESIGNED BY A REGISTERED PROFESSIONAL ENGINEER LICENSED IN THE PROJECT JURISDICTION HIRED BY THE CONTRACTOR.
- 3. DIMENSIONS AND ELEVATIONS OF EXISTING CONSTRUCTION GIVEN IN STRUCTURAL DRAWINGS ARE BASED ON INFORMATION CONTAINED IN VARIOUS ORIGINAL DESIGN AND CONSTRUCTION DOCUMENTS PROVIDED BY THE OWNER, AND LIMITED FIELD OBSERVATIONS AND MEASUREMENTS. THE CONTRACTOR SHALL VERIFY ALL INFORMATION PERTAINING TO EXISTING CONDITIONS BY ACTUAL MEASUREMENT AND OBSERVATION AT THE SITE. ALL DISCREPANCIES BETWEEN ACTUAL CONDITIONS AND THOSE SHOWN IN THE CONTRACT DOCUMENTS SHALL BE REPORTED TO THE ENGINEER OF RECORD FOR HIS EVALUATION BEFORE THE AFFECTED CONSTRUCTION IS PUT IN PLACE.

FRAMING LUMBER

- 1. ALL FRAMING LUMBER WORK SHALL CONFORM TO THE FOLLOWING GOVERNING STANDARDS
 - A. AMERICAN INSTITUTE OF TIMBER CONSTRUCTION, "TIMBER CONSTRUCTION MANUAL" LATEST EDITION. B. NATIONAL FOREST PRODUCTS ASSOCIATION "NATIONAL DESIGN SPECIFICATIONS FOR WOOD CONSTRUCTION," LATEST EDITION.
- 2. FRAMING LUMBER SHALL HAVE EACH PIECE GRADE STAMPED, SHALL BE SURFACED DRY (EXCEPT STUDS, WHICH SHALL BE KILN DRIED) AND SHALL CONFORM TO THE FOLLOWING SPECIES AND GRADE: RAFTERS AND JOISTS: DOUGLAS FIR-LARCH #2 OR HEM FIR #2
- BEAMS, GIRDERS AND HEADERS: DOUGLAS FIR-LARCH #1 OR HEM FIR #1 STUDS AND PLATES: DOUGLAS FIR-LARCH STUD GRADE OR HEM FIR STUD GRADE
- PRESERVATIVE-TREATED WOOD: PROVIDE TREATED DOUG-FIR #2 LUMBER COMPLYING WITH ACQ-D (CARBONATE). COPPER AZOLE (CA-B), OR SODIUM BORATE (SBX (DOT) WITH NaS10/2) AT ALL LUMBER IN CONTACT WITH CONCRETE OR MASONRY, OR AS OTHERWISE INDICATED ON ARCHITECTURAL DRAWINGS. ACZA TREATMENT IS NOT PERMITTED. TREATED LUMBER AND/OR PLYWOOD SHALL BEAR THE LABEL OF AN ACCREDITED AGENCY SHOWING 0.40 PCF RETENTION. WHERE LUMBER AND/OR PLYWOOD IS CUT OR DRILLED AFTER TREATMENT, THE TREATED SURFACE SHALL BE FIELD-TREATED WITH COPPER NAPTHENATE (THE CONCENTRATION OF WHICH SHALL CONTAIN A MINIMUM OF 2% COPPER METAL) BY REPEATED BRUSHING, DIPPING, OR SOAKING UNTIL THE WOOD ABSORBS NO MORE PRESERVATIVE.
- ALL WOOD FRAMING INCLUDING DETAILS FOR BRIDGING, BLOCKING, FIRE STOPPING, ETC., SHALL CONFORM TO THE LATEST EDITION OF THE "NATIONAL DESIGN SPECIFICATION FOR WOOD CONSTRUCTION" AND ITS SUPPLEMENTS AND SHALL BE INSTALLED IN ACCORDANCE WITH THE NFPA "MANUAL FOR HOUSE FRAMING" OR THE GOVERNING LOCAL/STATE BUILDING CODE.
- 5. FASTENING SHALL BE IN ACCORDANCE WITH THE MOST RESTRICTIVE OF: THE GOVERNING LOCAL/STATE BUILDING CODE, (LATEST EDITION), OR THE MANUFACTURER'S RECOMMENDED FASTENING SCHEDULES.
- 6. ALL FLUSH FRAMED CONNECTIONS SHALL BE MADE WITH APPROVED GALVANIZED STEEL JOIST OR BEAM HANGERS, MINIMUM 18 GAUGE. INSTALLED ACCORDING TO MANUFACTURER'S RECOMMENDATIONS.
- 7. WHERE FRAMING LUMBER IS FLUSH FRAMED TO MICROLLAM, STEEL OR FLITCH-PLATE GIRDER, SET THESE GIRDERS 1/2" CLEAR (MIN.) BELOW TOP OF FRAMING LUMBER, TO ALLOW FOR SHRINKAGE.
- 8. STUD BEARING WALLS ARE TO BE 2 X 6 AT EXTERIOR NEW WALLS AND 2 x 4 @ 16"o/c. AT THE INTERIOR, UNLESS NOTED OTHERWISE ON PLAN.
- 9. ALL RAFTERS AND JOISTS SHALL ALIGN DIRECTLY WITH STUDS BELOW, WHERE REQUIRED INSTALL ADDITIONAL STUDS.
- 10. LAP ALL PLATES AT CORNERS AND AT INTERSECTION OF PARTITIONS.
- 11. STAGGER ALL TOP AND BOTTOM PLATE SPLICES A MINIMUM OF 32 INCHES.
- 12. USE DOUBLE STUDS @ ENDS OF WALL AND ENDS OF WALL OPENINGS.
- 13. AT THE ENDS OF ALL BEAMS, HEADERS AND GIRDERS PROVIDE A BUILT UP OR SOLID POST WHOSE WIDTH IS AT LEAST EQUAL TO THE WIDTH OF THE MEMBER IT IS SUPPORTING AND WHOSE DEPTH IS 4" (NOM.) AT INTERIOR WALLS AND 6" (NOM.) AT EXTERIOR WALLS.
- 14. USE DOUBLE TRIMMERS AND HEADERS AT ALL FLOOR OPENINGS WHERE BEAMS ARE NOT DESIGNATED.
- 15. PROVIDE CROSS BRIDGING AT A MAXIMUM OF 8' o/c.
- 16. BUILT UP BEAMS LESS THAN 8" DEEP SHALL BE SPIKED TOGETHER WITH 2 16D NAILS @16"o/c. BUILT UP BEAMS GREATER THAN 8" DEEP SHALL BE SPIKED TOGETHER WITH 3 - 16D NAILS @16"o/c.
- 17. WHERE THERE IS NO PLYWOOD WALL SHEATHING, PROVIDE DIAGONALS AT ALL EXTERIOR CORNERS OF STUD WALLS AT EACH FLOOR. (1" x 4" BRACES LET INTO STUDS AND NAILED AT EACH STUD CROSSING WITH 2 - 10D NAILS.)
- 18. NO NEW OR EXISTING JOISTS SHALL BE CUT OR NOTCHED WITHOUT APPROVAL
- WOOD HEADER SCHEDULE ROUGH OPENING WIDTH HEADER

	2 x 4 WALL	2 x 6 WALL
LESS THAN 3'-0"	(2) 2 x 6	(3) 2 x 8
3'-1 TO 4'-0"	(2) 2 x 8	(3) 2 x 8
4'-1" TO 6'-0"	(2) 2 x 10	(3) 2 x 10
6'-1" TO 8'-0"	(2) 2 x 12	(3) 2 x 12
OVER 8'-0"	SEE PLANS	SEE PLANS

(1) JACK STUD FOR SPANS LESS THAN 4'-0' WIDE, NOTE: PROVIDE (2) JACK STUDS FOR SPANS LESS THAN 8'-0" WIDE. (3) JACK STUDS FOR SPANS OVER 8'-0" WIDE.

- 20. ALL LIGHT-GAUGE HANGERS SUPPORTING PRESERVATIVE TREATED WOOD SHALL MEET OR EXCEED G185 (1.85 OZ OF ZINC PER SQUARE FOOT). ALTERNATIVELY, STAINLESS STEEL CONNECTIONS MAY BE USED. FASTENERS SHALL MATCH THE HANGER FINISH AND MATERIAL.
- 21. WHERE JOIST ORIENTATION IS PARALLEL TO EXTERIOR STUD OR FOUNDATION WALLS, PROVIDE FULL-SECTION BLOCKING FOR 3 BAYS @ 4'-0" O.C. MAX. WHERE SHEATHING IS NOT CONTINUOUSLY FASTENED TO TOP OR BOTTOM OF JOIST. PROVIDE 18 GA x 1-1/2" x 1'-0" (MIN.) FLAT TENSION STRAP BETWEEN ALIGNED BLOCKING MEMBERS.
- 22. ALL SILL PLATES SHALL BE PRESSURE TREATED AND ANCHORED TO FOUNDATION WALLS WITH ½" DIA. HEADED ANCHOR BOLTS (ASTM F1554) @ 4'-0" O.C. AND WITHIN 12" OF ALL SILL PLATES SPLICES. (MIN, 7" EMBED.)

WOOD STRUCTURAL PANEL SHEATHING

- PROVIDE STRUCTURAL I PLYWOOD SHEATHING WITH BOND CLASSIFICATIONS APPROPRIATE TO THE END USE: "EXTERIOR" (PERMANENT EXPOSURE), OR "EXPOSURE I" (CONSTRUCTION EXPOSURE ONLY)
- 2. FLOOR SHEATHING: NOM. $\frac{3}{4}$ " THICK T&G PLYWOOD (48/24 SPAN RATING), APA STURD-I-FLOOR, OR ADVANTECH SUBFLOOR.
- 3. ROOF SHEATHING (STANDARD): NOM. 5/8" THICK T&G PLYWOOD (48/24 SPAN RATING).
- 4. WALL SHEATHING (STANDARD: NOM. ½" THICK PLYWOOD (32/16 SPAN RATING).
- 5. WALL SHEATHING (BEHIND SLATE, CLAY TILE, OR MASONRY VENEER): NOM. ¾" THICK PLYWOOD (48/24 SPAN RATING).
- 6. USE PLY CLIPS OR OTHER EDGE SUPPORT AS REQUIRED FOR PLYWOOD SHEATHING.
- 7. LEAVE $\frac{1}{16}$ " SPACE AT ALL PLYWOOD PANEL END JOINTS AND $\frac{1}{8}$ " SPACE AT ALL PANEL EDGE JOINTS.
- 8. UNLESS NOTED OTHERWISE, WALL SHEATHING SHALL BE FASTENED TO FRAMING WITH 6d COMMON NAILS (SUBFLOOR AND WALL) AND 8d COMMON NAILS (ROOF) @ 6" O.C. AT EACH SHEET PERIMETER AND 12" O.C. ELSEWHERE. PROVIDE 2x6 BLOCKING AT ALL FREE EDGES.
- 9. UNLESS NOTED OTHERWISE, ROOF SHEATHING SHALL BE FASTENED TO FRAMING WITH 8d COMMON NAILS @ 6" O.C. AT EACH SHEET PERIMETER AND 12" O.C. ELSEWHERE.
- 10. ALL FLOOR SHEATHING SHALL BE GLUED AND SCREWED TO FLOOR JOISTS USING AN APA APPROVED ADHESIVE AND #8 SCREWS @ 6" O.C. AT EACH SHEET PERIMETER AND 12" O.C. ELSEWHERE, UNLESS NOTED OTHERWISE.

ENGINEERED WOOD PRODUCTS

- 1. WOOD I-JOISTS: PROVIDE ENGINEERED WOOD I-JOISTS, SIZES AND SERIES AS SHOWN, AS MANUFACTURED BY ILEVEL BY WEYERHAEUSER OR APPROVED EQUAL. INSTALL IN STRICT COMPLIANCE WITH THE MANUFACTURER'S STANDARD RECOMMENDATIONS AND DETAILS, INCLUDING CONSTRUCTION BRACING, MINIMUM BEARING LENGTHS, WEB STIFFENERS, SQUASH BLOCKS, BLOCKING, KNOCK-OUTS AND HOLES, ETC.
- 2. RIM BOARDS: PROVIDE CONTINUOUS 1 $\frac{1}{2}$ " THICK RIM BOARDS, TIMBERSTRAND LSL AS MANUFACTURED BY ILEVEL BY WEYERHAEUSER OR APPROVED EQUAL. INSTALL IN COMPLIANCE WITH THE MANUFACTURER'S RECOMMENDATIONS AT THE PERIMETER OF ALL FLOOR PLATFORMS.
- MICRO-LAM BEAMS: PROVIDE ENGINEERED BEAMS, SIZES AS SHOWN, MICROLLAM LVL OR PARALLAM PSL AS MANUFACTURED BY ILEVEL BY WEYERHAEUSER OR APPROVED EQUAL. INSTALL IN STRICT COMPLIANCE WITH THE MANUFACTURER'S STANDARD RECOMMENDATIONS AND DETAILS.
- GLUED LAMINATED TIMBER (SOFTWOOD): PROVIDE ENGINEERED BEAMS, SIZES AS SHOWN, IN ACCORDANCE WITH AITC 117-84 DESIGN STANDARD SPECIFICATIONS FOR STRUCTURAL GLUED LAMINATED TIMBER OF SOFTWOOD SPECIES. UNLESS NOTED OTHERWISE, ALL LAMINATIONS SHALL BE SOUTHERN PINE.

NEWMAN R		
VERONA, NEW JERSEY	,	
ZONINO DICTRICT	DECIDENTIAL D.50	
ZONING DISTRICT	RESIDENTIAL - R-50	
CLIMATE ZONE	4A	
TAX BLOCK	108	
TAX LOT	2	

ROOF DEAD LOAD: ROOF LIVE LOAD: 30 PSF 20 PSF FLOOR DEAD LOAD (AT WOOD FINISH): FLOOR DEAD LOAD (AT TILE FINISH): 30 PSF 40 PSF 5. FLOOR LIVE LOAD: 200 PSF GUARDRAILS AND HANDRAILS:

50 PSF GUARDRAIL INFILL COMPONENTS: 8. STAIRS: 40 PSF 115 MPH, 3-SEC GUSTS 9. WIND LOAD: IO. RISK CATEGORY:

BULK CALCULATIONS

IMPERVIOUS COVERAGE PROPOSED

LOT AREA: 6,487 SF BUILDING COVERAGE PROPOSED 1,415 SF EXISTING TO REMAIN IMPERVIOUS COVERAGE PROPOSED 2,598 SF

BUILDING AREA

EXISTING FIRST FLOOR: 1,546 SQ.FT. O SQ.FT. ADDITION TO FIRST FLOOR: TOTAL FIRST FLOOR: 1,546 SQ.FT. EXISTING SECOND FLOOR: 715 SQ.FT. ADDITION TO SECOND FLOOR: O SQ.FT. TOTAL SECOND: 715 SQ.FT.

2 STORY W/ BASEMENT

40%

BUILDING HEIGHT

EXISTING HEIGHT:

29'-02" PROPOSED HEIGHT EXISTING TO REMAIN

<u>SETBACKS</u>

PROPOSED REQUIRED SOUTH FRONT SETBACK: EXISTING TO REMAIN 30'-0" NORTH REAR SETBACK: 20'-0" (ACCESSORY STRUCTURE) EAST SIDE SETBACK: WEST SIDE SETBACK: 9'-4" 8' (18' TOTAL REQ'D)

CODE COMPLIANCE


GOVERNING CODE OF NEW ADDITION AND INTERIOR ALTERATIONS TO BE PER:

- INTERNATIONAL RESIDENTIAL CODE, 2018
- REHABILITATION SUBCODE -NJAC 5:23-6
- NATIONAL ELECTRICAL CODE, 2017
- NATIONAL STANDARD PLUMBING CODE, 2018
- INTERNATIONAL MECHANICAL CODE, 2018
- INTERNATIONAL ENERGY CONSERVATION CODE, 2018 (RESIDENTIAL)



PROJECT PHOTOGRAPH

N.T.S.

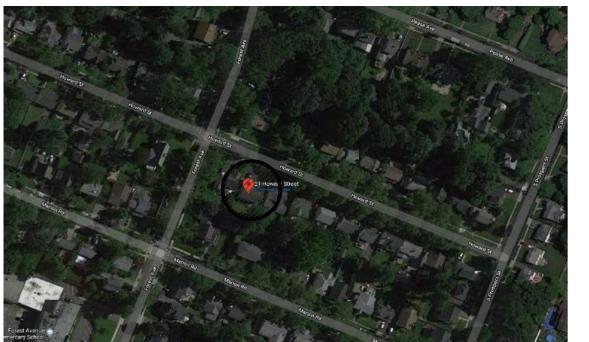

AERIAL MAP

CONSTRUCTION AND


SECTIONS

N.T.S. DRAWING LIST - JOB # ES-2003 BUILDING DATA BLOCK: 108 LOT: 2 ARCHITECTURAL: A-OI - CODES, NOTES AND ZONE: R-50 DETAILS CONSTRUCTION CLASS: 5B A-O2 - DEMOLITION,

USE GROUP: R

ARCHITECTS


EScott Architects, LLC 12 Beechwood Road Verona, NJ 07044 P. 973.552.8886 | F. 973.680.1905 | info@escottarchitects.com

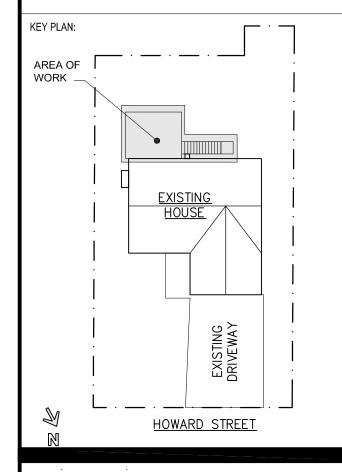

10/16/20 ISSUED FOR PERMIT NO. DATE DESCRIPTION

> NEWMAN RESIDENCE

21 HOWARD STREET VERONA, NJ

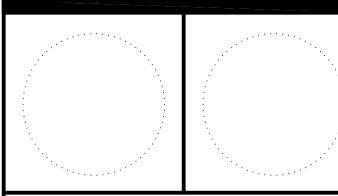


DRAWING TITLE:


PROJECT:


SITE PLAN, CODES AND **DETAILS**


DRAWN BY: CHECKED BY: ES DATE: ROJECT NO: **SEPT 2020** ES-2003

DRAWING NO:

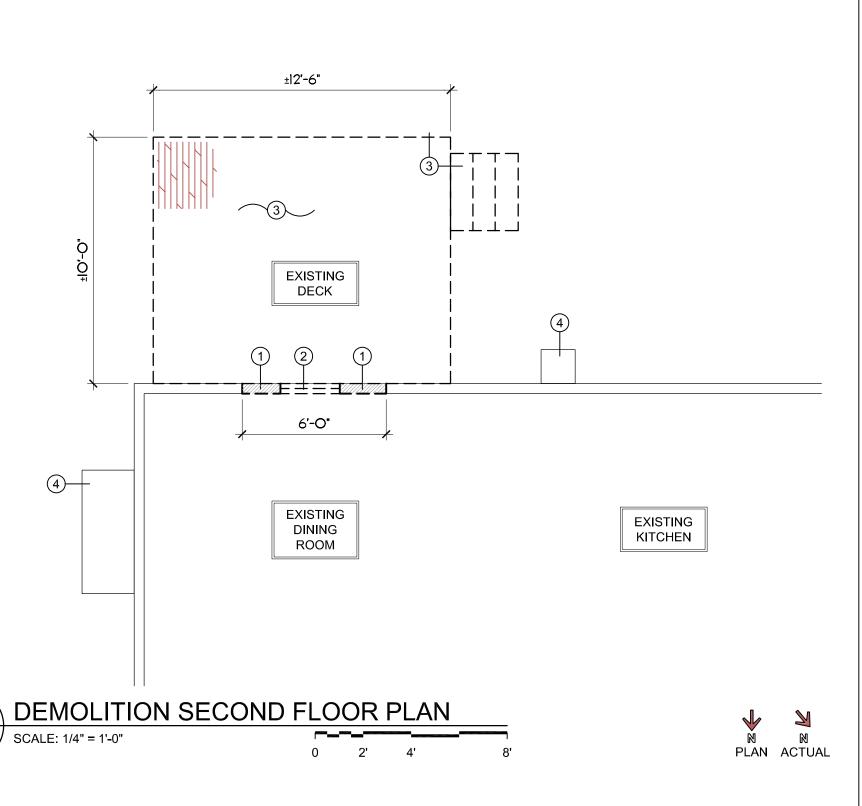

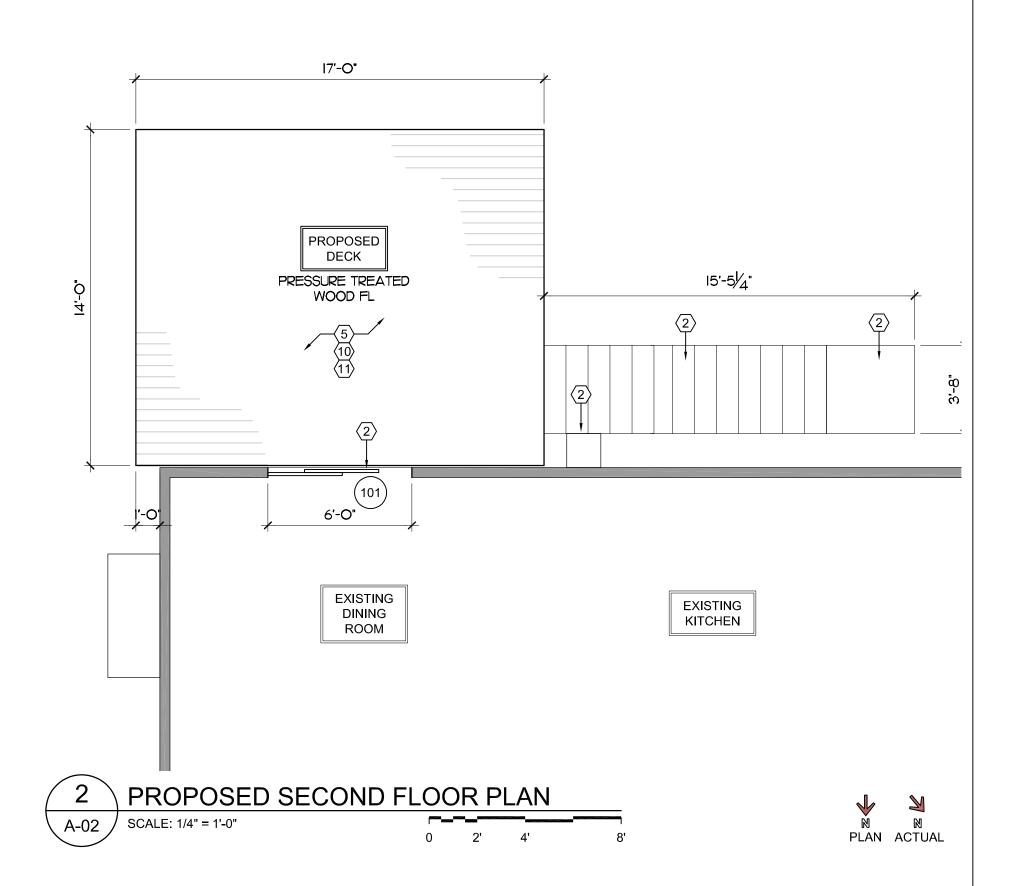

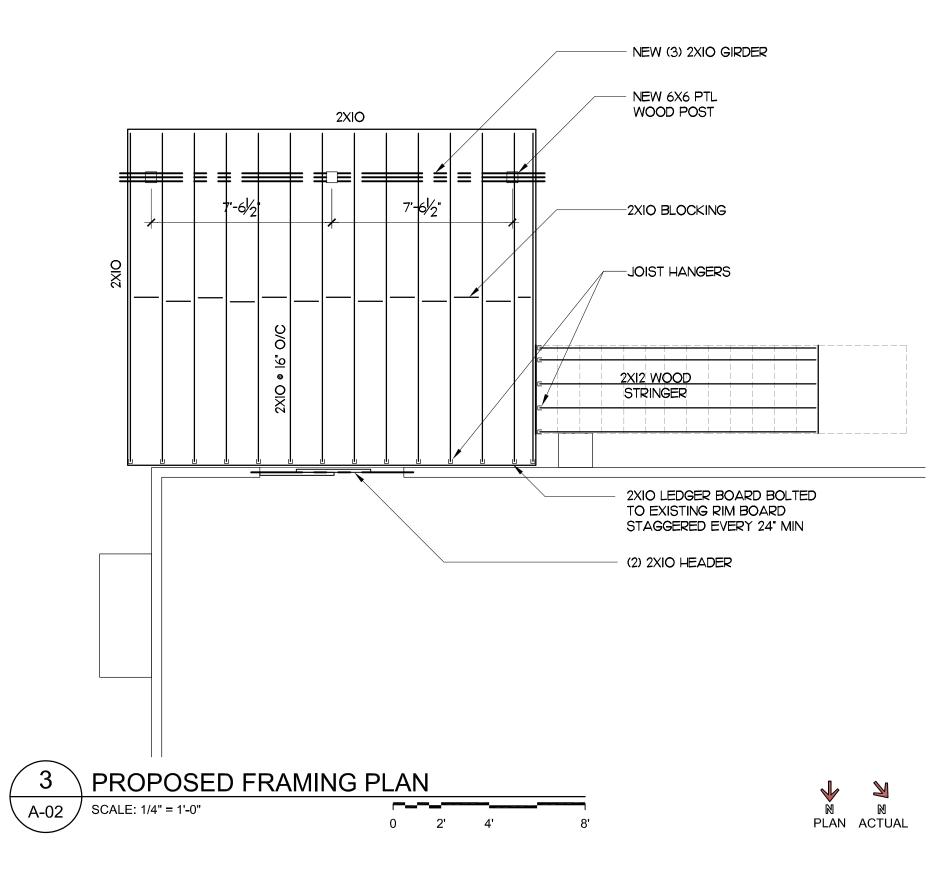

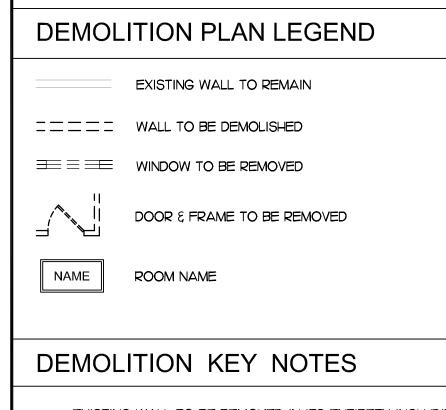


- EXISTING WALL TO BE REMOVED IN ITS ENTIRETY INCLUDING SHEATHING, STUDS, INSULATION, BLOCKING & THE LIKE.
- REMOVE EXISTING WINDOW, WINDOW FRAMING, TRIM AND ASSOCIATED HARDWARE IN ITS ENTIRETY.
- DEMOLISH EXISTING WOOD DECK, STAIRS, RAILING AND LEDGER BOARD.
- (4) EXISTING CHIMNEY TO REMAIN.

A-02 /


GENERAL DEMOLITION NOTES

CONTRACTOR IS RESPONSIBLE FOR PROVIDING TEMPORARY DUST AND DEBRIS PROTECTION BETWEEN AREAS OF DEMOLITION AND AREAS IN WHICH NO WORK IS TAKING PLACE. LOCATION OF SUCH PROTECTION SHALL BE VERIFIED WITH OWNER PRIOR TO COMMENCING WORK.

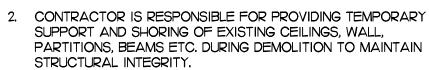

- 3. CONTRACTOR SHALL COVER AND TARP AREAS OF ROOF DURING DEMOLITION AND CONSTRUCTION TO ENSURE NO WATER AND DEBRIS PENETRATION.
- 4. CONTRACTOR IS TO COORDINATE ALL DEMOLITION WITH OTHER TRADES.
- 5. CONTRACT DRAWINGS ARE NOT INTENDED TO REPRESENT EXACT DIMENSIONS. FIELD DIMENSIONS ARE THE RESPONSIBILITY OF THIS CONTRACTOR FOR ALL DEMOLITION WORK.
- 6. EXISTING ELECTRICAL CONDUIT, WIRES AND BOXES IN AREAS OF WORK SHALL BE REMOVED AND REPLACED WITH NEW. ENSURE EXISTING OUTLETS, SWITCHES AND LIGHTS TO REMAIN ARE IN WORKING ORDER.
- 7. CONTRACTOR TO VERIFY NO EXISTING TELECOMMUNICATION WIRES, COAXIAL CABLE AND OTHER EXISTING WIRING OR DEVICES ARE REMOVED AND OR DAMAGED DURING DEMOLITION UNLESS OTHERWISE NOTED IN DRAWINGS.
- 8. ALL EXISTING SIDING TO REMAIN AS MUCH AS POSSIBLE FOR NEW WORK.

CONSTRUCTION PLAN LEGEND

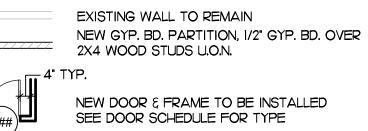

SEE WINDOW SCHEDULE FOR TYPE

NEW WINDOW TO BE INSTALLED

NAME

ROOM NAME

CONSTRUCTION KEY NOTES


- NEW TYP. WOOD STUD EXTERIOR WALL WITH GYP. BD. ON INTERIOR SIDES OF WALL. SHEATHING, VAPOR BARRIER & SIDING AS REQUIRED ON EXTERIOR SIDE OF WALL.
- NEW PRESSURE TREATED WOOD DECK WITH IX6 DECKING BOARDS AND NEW PTL WOOD RAILING.
- MAINTAIN MIN 2" AROUND CHIMNEY WITH WOOD FRAMING
- PROVIDE INEVVISIANCE TO EXISTING CONC SLAB. PROVIDE NEW STAIRS AND STRINGERS FROM DECK DOWN
- $\langle 5 \rangle$ NEW ENTRY SLIDING DOOR. SEE WINDOW SCHEDULE.

GENERAL CONSTRUCTION NOTES

- CONTRACTOR IS TO VERIFY ALL EXISTING CONDITIONS AND NOTIFY ARCHITECT OF ANY DISCREPANCIES PRIOR TO COMMENCEMENT OF WORK.
- ALL PENETRATIONS THROUGH DRYWALL AND MASONRY SURFACES INCLUDING BUT NOT LIMITED TO PIPE, CONDUIT, DUCTWORK, GRILLES, REGISTERS, DEVICE BOXES, HANGER RODS, ETC. SHALL HAVE THEIR COMMON JOINTS WITH DRYWALL AND/OR MASONRY CAULKED TO PROVIDE AN AIRTIGHT SEAL.
- 3. ALL NEW EXTERIOR WALLS TO BE INSULATED WITH R-20 BATT INSULATION, ROOF TO HAVE R-49, FLOOR TO HAVE R-30 AS PER IECC 402.I.I AND AS REQUIRED.
- 4. PROVIDE ALL NEW TRIM TO MATCH EXISTING BASE, WINDOW, DOOR, AND CROWN MOULDING TRIM. CONFIRM TRIM WITH OWNER AND/OR ARCHITECT. TYPICAL FOR ALL NEW AND RENOVATED SPACES.
- 5. CONTRACTOR IS TO COORDINATE ALL RENOVATION WORK WITH ALL OTHER TRADES AS REQUIRED.
- 6. GC TO PAINT EXTERIOR AS SELECTED BY OWNER.
- 7. CONTRACT DRAWINGS ARE NOT INTENDED TO REPRESENT EXACT DIMENSIONS. FIELD DIMENSIONS ARE THE RESPONSIBILITY OF THIS CONTRACTOR FOR ALL PHASES INCLUDING BIDDING, FABRICATION, COORDINATION AND CONSTRUCTION.
- 8. ALL EXTERIOR GLASS DOORS, NOTED WINDOWS AND WINDOWS BELOW 18" AFF TO HAVE SAFETY GLAZING - REQUIRES MARKING: CPSC 16: CFR 1201.
- 9. PROVIDE ALL FIRESTOPPING REQUIRED PURSUANT TO IRC 2018,
- 10. CONTRACTOR SHALL BE RESPONSIBLE FOR ALL INSPECTIONS.

NEW DOOR HEADER (SEE HEADER SCHEDULE) NEW BITUMINOUS OR COPPER FLASHING UP BEHIND EXISTING SIDING AND BEHIND LEDGER BOARD. ADDITIONAL FLASHING DRIP EDGE NEW WOOD GUARD RAIL 42" MIN OFF FIN FLOOR WITH <u>PROPOSED</u> BALUSTERS MAX 4" SPACING-**BEDROOM** (3) 2XIO WOOD BEAM -

EXISTING EXTERIOR WALL

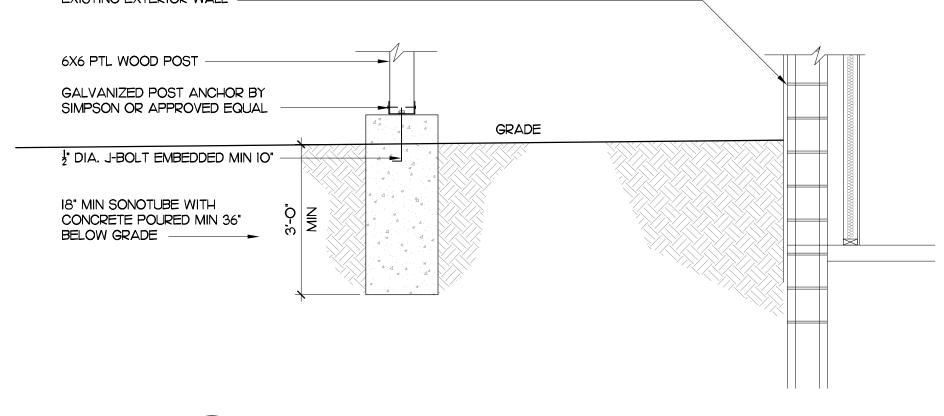

0 2' 4'

PROPOSED SECTION

SCALE: 1/4" = 1'-0"

A-02

OCT 2020 DRAWING NO:

SHEET:

DRAWING TITLE: DEMO, CONSTRUCT & ELECTRICAL PLANS AND NOTES

ARCHITECTS

EScott Architects, LLC

12 Beechwood Road Verona, NJ 07044 P. 973.552.8886 | F. 973.680.1905 | info@escottarchitects.com

HOWARD STREET

10/16/20 ISSUED FOR PERMIT

NEWMAN

RESIDENCE

21 HOWARD STREET

VERONA, NJ

NO. DATE DESCRIPTION

PROJECT:

AREA OF

DRAWN BY: CHECKED BY: ES DATE: ROJECT NO: ES-2004

DOOR SCHEDULE

#	TYPE OF DOOR	HARDWARE	WIDTH	HEIGHT	NOTES
IRSTE	FLOOR				
101	NEW SLIDING EXTERIOR DOOR	ENTRY	6'-0"	6'-8"	DOUBLE PANE LOW-E TEMPERED GLAZIN
				1	

- ALL EXISTING ROOM ENTRY DOORS TO BE REPLACED AS SHOWN.
- ALL INTERIOR DOORS TO HAVE SOLID BRASS DOOR KNOBS + HARDWARE TO MATCH EXISTING, CONFIRM FUNCTIONS AND MATERIAL WITH
- ALL DOORS TO BE SOLID CORE WOOD 6 PANEL DOORS. CONFIRM DOOR STYLE AND MATERIAL WITH OWNER.
- CONFIRM NEW DOOR HEIGHT WITH EXISTING DOORS AND EXISTING OPENINGS WHERE REQUIRED.